PUBLIC SEWER IMPROVEMENT PLANS

GENERAL NOTES:

1. NO PERSON SHALL PERFORM ANY CONSTRUCTION ACTIVITY OR INSTALL ANY OBJECTS WITHIN THE PUBLIC RIGHTS-OF-WAY OR EASEMENTS OF THE CITY OF RIVERSIDE WITHOUT A VALID CONSTRUCTION PERMIT OR, A STREET OPENING PERMIT OR AN ENCROACHMENT PERMIT ISSUED BY THE CITY'S PUBLIC WORKS DEPARTMENT.

2. IT SHALL BE THE RESPONSIBILITY OF THE CONTRACTOR TO CLEAR THE RIGHT OF WAY IN ACCORDANCE WITH THE PROVISIONS OF LAW AS IT AFFECTS EACH UTILITY INCLUDING IRRIGATION LINES AND APPURTENANCES AND AT NO COST TO THE CITY.

3. CONSTRUCTION SHALL BE IN ACCORDANCE WITH THE CITY OF RIVERSIDE DEPARTMENT OF PUBLIC WORKS, STANDARD DRAWINGS, ITS SUPPLEMENTAL NOTES AND THE STANDARD SPECIFICATIONS FOR PUBLIC WORKS CONSTRUCTION, CURRENT

4. THE PRIVATE ENGINEER SIGNING THESE PLANS IS RESPONSIBLE FOR ASSURING THE ACCURACY AND ACCEPTABILITY OF THE WORK HEREON. IN THE EVENT OF DISCREPANCIES ARISING DURING CONSTRUCTION, THE PRIVATE ENGINEER SHALL BE RESPONSIBLE FOR DETERMINING AN ACCEPTABLE SOLUTION AND REVISING THE PLANS FOR APPROVAL BY THE CITY.

5. QUANTITIES SHOWN ARE FOR INFORMATION ONLY AND THE CITY OF RIVERSIDE IS NOT RESPONSIBLE FOR THEIR ACCURACY.

6. THE DEVELOPER SHALL BE RESPONSIBLE FOR PRESERVING OR RE-ESTABLISHING AND REFERENCING SURVEY MONUMENTS DESTROYED, DISTURBED OR BURIED AS A RESULT OF CONSTRUCTION SHOWN HEREON.

7. SEE "STREET LIGHTING PLANS" FOR QUANTITY AND LOCATION OF REQUIRED STREET LIGHTS.

8. ALL FLAGGED ELEVATIONS SHALL BE STAKED IN THE FIELD BY THE PRIVATE ENGINEER.

9. WHERE NEW PAVEMENT IS TO JOIN THE EXISTING PAVEMENT, THE EDGE OF THE EXISTING PAVEMENT SHALL BE TRIMMED IN A SMOOTH AND STRAIGHT LINE. CONSTRUCT MATCH-UP PAVING AS SHOWN ON THE PLANS AND OVERLAY PAVING AS DIRECTED IN THE FIELD TO PRODUCE A SMOOTH SECTION.

10. THE DEVELOPER AND/OR CONTRACTOR SHALL CONTACT THE STREET DIVISION (351-6127) TO PICK UP ANY EXISTING STD. 180 BARRICADES THAT ARE BEING REMOVED. THE CITY'S INSPECTOR WILL MAKE THE FINAL DETERMINATION ON WHETHER A BARRICADE CAN BE RELOCATED.

11. ON ALL AREAS WITHIN PUBLIC RIGHT OF WAY WHERE THE FILL IS ONE (1) FOOT OR GREATER, A LETTER WILL BE REQUIRED FROM THE SOILS ENGINEER, CERTIFYING THE COMPACTION OF THE FILL BELOW SUBGRADE, PRIOR TO ISSUANCE OF THE CONSTRUCTION PERMIT/CUT SHEETS.

12. THE CONTRACTOR SHALL CALL IN A LOCATION REQUEST TO UNDERGROUND SERVICE ALERT (USA), PHONE # 1-800-227-2600, TWO WORKING DAYS BEFORE DIGGING. NO CONSTRUCTION PERMIT WILL BE ISSUED BY THE PUBLIC WORKS DEPARTMENT INVOLVING EXCAVATION FOR UNDERGROUND FACILITIES UNLESS THE APPLICANT HAS BEEN PROVIDED AN INQUIRY IDENTIFICATION NUMBER BY U.S.A.

13. CONTRACTOR IS TO VERIFY EXISTING SEWER ELEVATION PRIOR TO CONSTRUCTION.

14. LOCATION OF LATERALS TO BE DETERMINED IN THE FIELD AT THE DIRECTION OF THE OWNER. AVOID CONFLICT WITH PROPOSED AND/OR EXISTING FACILITIES.


15. NO FINISHED FLOOR ELEVATION SHALL BE LESS THAN 6" ABOVE THE UPPER MANHOLE RIM ELEVATION OF THE SEWER LINE SEGMENT BEING CONNECTED TO, WITHOUT HAVING A PROPER BACKWATER VALVE INSTALLED IN THE LATERAL.

16. A PLUG SHALL BE INSTALLED AND WILL REMAIN IN PLACE WHERE THE NEW SEWER CONNECTS WITH THE EXISTING SEWER UNTIL THE NEW SEWER IS ACCEPTED BY THE CITY.


17. THE SEWER CONTRACTOR SHALL ADJUST MANHOLES TO FINAL GRADE AFTER PAVING IS COMPLETED.

18. IN PAVEMENT OVERLAY AREAS, ANY DISTRESSED EXISTING PAVEMENT SHALL BE REMOVED AND REPLACED AS DIRECTED BY THE INSPECTOR PRIOR TO OVERLAYING WITH A.C. PAVING.

HUNTER PARK - PALMYRITA INDUSTRIAL COMPLEX

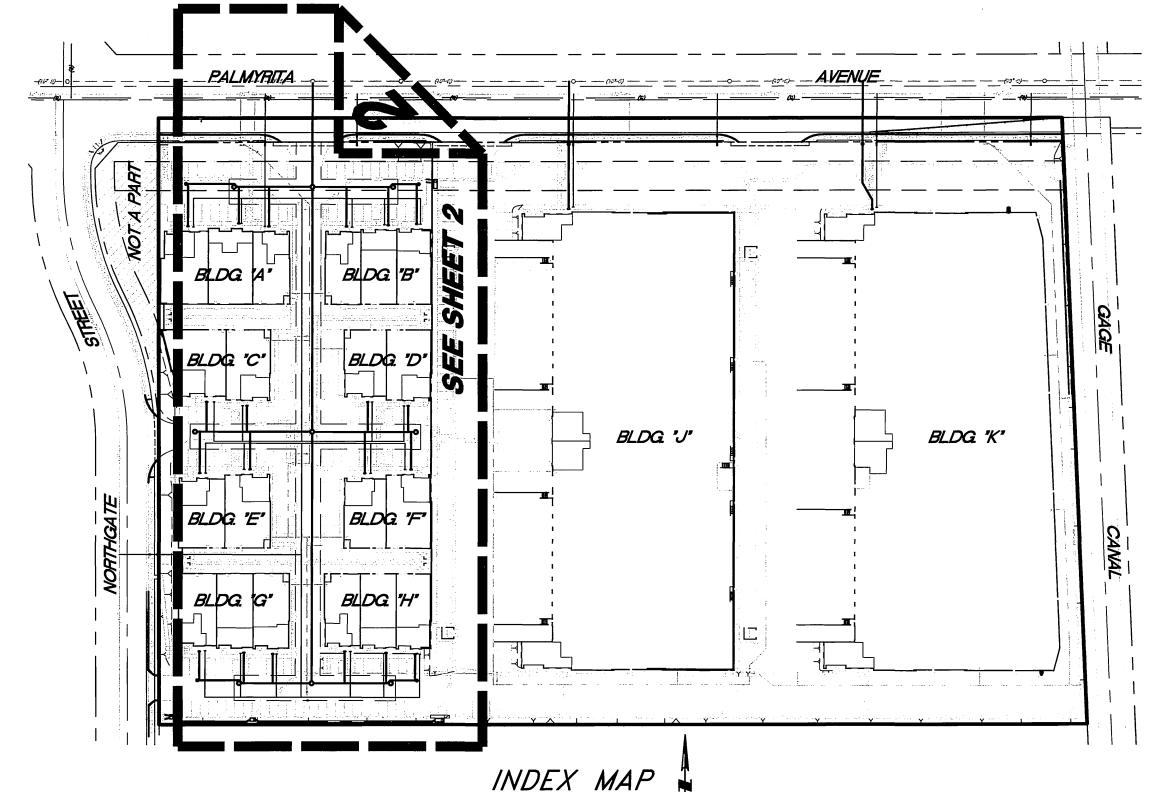

SCALE: 1" = 100'

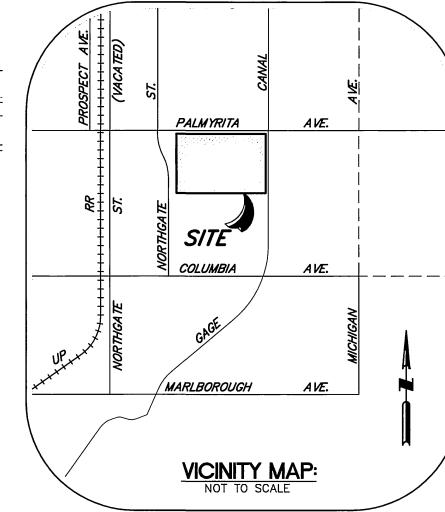

LIST OF ARREVIATIONS I ECENID

| <u> </u> | <u>UF</u> | <u>ABBREVIATIONS</u> | LEC |
|----------------|-----------|--------------------------------|------------------|
| ВС | | BEGIN CURVE | DE. |
| BVC | | BEGIN VERTICAL CURVE | <u>DL</u> |
| BW | | BOTTOM OF WALL | EXIST. |
| CB | | CATCH BASIN | FINISF |
| CF | | CURB FACE | FIIVISF |
| CFS | | CUBIC FEET PER SECOND | WA TE |
| D/W | | DRIVEWAY | CEWE |
| DWG | | DRAWING | SEWE |
| EC | | END CURVE | FIRE . |
| ELEV | | ELE VA TION | |
| EP | | EDGE OF PAVEMENT | STREE |
| ESMT. | | EASEMENT | DIREC |
| EVC | | END VERTICAL CURVE | |
| F.F. | | FINISH FLOOR ELEVATION | SLOPI |
| FL | | FLOWLINE | RETAI |
| GB | | GRADE BREAK | //L/A/ |
| GTR | | GUTTER | MASO |
| HDWL | | HEADWALL | PROP |
| H | | HORIZONTAL | PRUP |
| H.P. | | HIGH POINT | SUBD |
| INV. | | INVERT | |
| <i>L</i> | | LENGTH | |
| LF | | LINEAL FEET | |
| LMD | | LANDSCAPE MAINTENANCE DISTRICT | CEME |
| L.P. | | LOW POINT | <u>SEWE</u> |
| NO N. T. S. | | NUMBER | (1) cons |
| N. 1.3. PAD | | NOT TO SCALE PAD ELEVATION | |
| P.I.P. | | PROTECT IN PLACE | (2) <i>INSTA</i> |
| RCP | | REINFORCED CONCRETE PIPE | (Z) INICTA |
| SD | | STORM DRAIN | (3) INSTA |
| 5D ST | | STREET | (4) CONS |
| <i>J</i> , | | JINLLI | |

| SEWER IMPROVEMENT CONSTRUCTION NOTES: | <u>QUANTITIE</u> |
|--|------------------|
| 1) CONSTRUCT TRENCH BACKFILL AND REPAIR PER CITY OF RIVERSIDE STD. DWG. NO. 453 (2 SHEETS) | 275 SF |
| 2 INSTALL 8" VCP SEWER MAIN | 625 LF |
| (3) INSTALL 10"x8" SEWER SADDLE | 1 EA. |
| 4 CONSTRUCT PRECAST CONCRETE SEWER MANHOLE PER CITY OF RIVERSIDE STD. DWG. NO. 500 | 1 EA. |
| 5 INSTALL 4" VCP SEWER LATERAL | 709 LF |
| (6) INSTALL SEWER CLEANOUT PER CITY OF RIVERSIDE STD. DWG. NO. 560 | 4 EA |

LEGAL DESCRIPTION

THAT PORTION OF LOT 6 IN SECTION 17, TOWNSHIP 2 SOUTH, RANGE 4 WEST, SAN BERNARDINO BASE AND MERIDIAN. AS SHOWN BY MAP OF LAND OF THE EAST RIVERSIDE LAND COMPANY ON FILE IN BOOK 6, PAGE 44 OF MAPS. RECORDS OF SAN BERNARDINO COUNTY. CALIFORNIA. LYING WESTERLY OF THE WESTERLY LINE OF THE RIGHT OF WAY OF THE GAGE CANAL.

LOT 7 IN SECTION 17, TOWNSHIP 2 SOUTH, RANGE 4 WEST, SAN BERNARDINO BASE AND MERIDIAN, AS SHOWN BY MAP OF LAND OF THE EAST RIVERSIDE LAND COMPANY ON FILE IN BOOK 6, PAGE 44 OF MAPS, RECORDS OF SAN BERNARDINO COUNTY, CALIFORNIA.

NOTICE TO CONTRACTORS

CONSTRUCTION CONTRACTOR AGREES THAT IN ACCORDANCE WITH GENERALLY ACCEPTED CONSTRUCTION PRACTICES, CONSTRUCTION CONTRACTOR WILL BE REQUIRED TO ASSUME SOLE AND COMPLETE RESPONSIBILITY FOR JOB SITE CONDITIONS DURING THE COURSE OF CONSTRUCTION OF THE PROJECT, INCLUDING SAFETY OF ALL PERSONS AND PROPERTY; THAT THIS REQUIREMENT SHALL BE MADE TO APPLY CONTINUOUSLY AND NOT BE LIMITED TO NORMAL WORKING HOURS, AND CONSTRUCTION CONTRACTOR FURTHER AGREES TO DEFEND, INDEMNIFY AND HOLD DESIGN PROFESSIONAL HARMLESS FROM ANY AND ALL LIABILITY, REAL OR ALLEGED, IN CONNECTION WITH THE PERFORMANCE OF WORK ON THIS PROJECT, EXCEPTING LIABILITY ARISING FROM THE SOLE NEGLIGENCE OF DESIGN PROFESSIONAL.

ALL CONTRACTOR AND SUBCONTRACTORS PERFORMING WORK SHOWN ON OR RELATED TO THESE PLANS SHALL CONDUCT THEIR OPERATIONS SO THAT EMPLOYEES ARE PROVIDED A SAFE PLACE TO WORK AND THE PUBLIC IS PROTECTED. ALL CONTRACTORS AND SUBCONTRACTORS SHALL COMPLY WITH THE "OCCUPATIONAL SAFETY AND HEALTH REGULATIONS" OF THE U.S. DEPARTMENT OF LABOR AND WITH THE STATE OF CALIFORNIA DEPARTMENT OF INDUSTRIAL RELATIONS "CONSTRUCTION SAFETY ORDERS". THE CIVIL ENGINEER SHALL NOT BE RESPONSIBLE IN ANY WAY FOR THE CONTRACTOR OR SUBCONTRACTORS COMPLIANCE WITH SAID REGULATIONS

PRIVATE ENGINEER'S NOTICES TO CONTRACTORS

THE EXISTENCE AND APPROXIMATE LOCATION OF ANY UNDERGROUND UTILITIES OR STRUCTURES SHOWN ON THESE PLANS ARE OBTAINED BY A SEARCH OF AVAILABLE RECORDS. TO THE BEST OF OUR KNOWLEDGE, THERE ARE NO EXISTING UTILITIES OR STRUCTURES EXCEPT AS SHOWN ON THESE PLANS. THE ENGINEER ASSUMES NO LIABILITY AS TO THE EXACT LOCATION OF SAID LINES NOR FOR UTILITIES OR IRRIGATION LINES WHOSE LOCATIONS ARE NOT SHOWN. THE CONTRACTOR SHALL BE RESPONSIBLE FOR NOTIFYING ALL UTILITY AND IRRIGATION COMPANIES PRIOR TO WORK ON EXCAVATION TO DETERMINE EXACT LOCATION OF ALL LINES AFFECTING THIS WORK. WHETHER OR NOT SHOWN HEREON, AND FOR ANY DAMAGE OR PROTECTION OF THESE LINES.

THE CONTRACTOR SHALL CALL IN A LOCATION REQUEST TO UNDERGROUND SERVICE ALERT (U.S.A.) PHONE 1-800-422-4133 TWO (2) WORKING DAYS PRIOR TO DIGGING. NO CONSTRUCTION PERMIT ISSUED BY PUBLIC WORKS DEPARTMENT SHALL BE VALID INVOLVING UNDERGROUND FACILITIES UNLESS THE APPLICANT HAS AN INQUIRY IDENTIFICATION NUMBER ISSUED BY U.S.A.

OWNER/DEVELOPER

PANATTONI DEVELOPMENT COMPANY 18111 VON KARMEN AVENUE, SUITE 500 IRVINE, CALIFORNIA 92591 (949) 474-7830 OFFICE `(949) 474–7833 FAX ATTÉNTION: TAYLOR GERRY

CIVIL ENGINEER

SB&O. INC. 1035 SOUTH MILLIKEN AVENUE, SUITE "E" ONTARIO, CALIFORNIA 91761 (909) 635-0335 OFFICE (909) 635-0365 FAX ATTÉNTION: DON BROOKS

ASSESSOR'S PARCEL No.('s) 257-020-003, -004

ACREAGE 13.78 AC = TOTAL PROPERTY IN QUESTION

SHEET INDEX


DESCRIPTION

ONSITE PUBLIC SEWER PLAN AND PROFILE ONSITE PUBLIC SEWER PLAN LATERALS

8 33C334610 PW05-0506 SEWER IMPROVEMENT PLANS HUNTER PARK — PALMYRITA S-<u>1936</u> INDUSTRIAL COMPLEX TITLE SHEET D.R.: P04-1464 & I.S.: P05-0043 SHEET I OF SVERT. SCALE: N/A HORIZ. SCALE: N/A FILE NO. *61702.10*

PUBLIC UTILITIES DEPARTMENT ELECTRIC DIVISION APPROVED BY WATER DEPARTMENT DIVISION MW Melen APPROVED BY DAŤE FIRE DEPARTMENT

Inderground Service Alert Call: TOLL FREE 1-800 227-2600

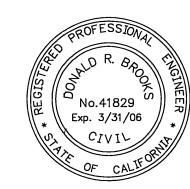



1035 South Milliken Ave, Ste E Ontario, CA 91761 P: (909) 635-0335 F: (909) 635-0365 www.sboinc.com

STANDARD SIDEWALK

TOP OF CURB TOP OF FOOTING

TOP OF WALL

VERTICAL WIDTH

TOP OF RETAINING PORTION OF WALL

LEAD AND TACK IN THE TOP OF CURB 3.5' N'LY OF THE BCR OF THE N.W. CURB RETUR PALMYRITA AND IOWA INTERSECTION. ELEVATION: 918.908

BENCHMARK

| | | | | | CITY | OF | RIVE | RSIDE, CALIFORNIA |
|------|--------|----------------------------|-------|------|-------------------------|-----|------------|-------------------|
| | | | | _ | PUBLIC WORKS DEPARTMENT | | | |
| IRN, | | | | | APPROVED BY | BY | DATE | APPROVED BY |
| | | | | | PRINCIPAL ENGINEER | 4 | 10/24/2005 | Thursday |
| | | | | | TRAFFIC ENGINEER | | | CITY ENGINEER |
| | MARK | REVISIONS | APPR. | DATE | STREET SERVICES | Alf | 9/30/08 | . 6.1- |
| | DESIGN | ed by drawn by! checked by | L | DB | | | | DATE 10/30/05 |

